
GENERAL NOTES

- 1. THE WORK HEREIN REQUIRED INCLUDES A HYDRAULICALLY DESIGNED SPRINKLER SYSTEM AS SPECIFIED IN THE DOCUMENTS AND AS APPROVED BY THE ARCHITECT.
- 2. THE FIRE PROTECTION DRAWINGS ARE DIAGRAMMATIC AND ARE TO BE USED FOR THE PURPOSE OF ESTABLISHING GENERAL LOCATIONS OF PIPING RUNS, SIZES OF PIPING, AND QUANTITIES OF FIXTURES AND EQUIPMENT TO BE FURNISHED HEREIN. REFER TO ARCHITECTURAL DRAWINGS FOR DIMENSIONS FOR EXACT LOCATIONS OF ALL SPRINKLER HEADS, AND EQUIPMENT, INCLUDING MOUNTING HEIGHTS. IN THE EVENT OF CONFLICT OR IF DIMENSIONS ARE NOT SHOWN, OBTAIN FIELD DIRECTIVE FROM THE ARCHITECT AS TO THE LOCATIONS OF ALL VISIBLE EQUIPMENT.
- 3. ALL PIPING SHOWN ON THESE PLANS OR THOSE TO BE DESIGNED HEREIN SHALL BE RUN CONCEALED ABOVE SUSPENDED CEILINGS, IN CHASES, OR IN PARTITIONS UNLESS SPECIFICALLY
- 4. ALL SPRINKLER HEADS IN CEILING TILES SHALL BE LOCATED IN THE EXACT CENTER OF TILE UNLESS SPECIFICALLY APPROVED OTHERWISE BY THE ARCHITECT.
- 5. REFER TO ARCHITECTURAL REFLECTED CEILING PLANS FOR CEILING HEIGHTS AND CEILING MATERIALS AND LAYOUTS. REFER TO THE RESPECTIVE PLUMBING, HVAC AND ELECTRICAL DRAWINGS FOR LIGHTING, DIFFUSER AND REGISTER LAYOUTS IN CEILINGS AND FOR PIPING, DUCTWORK AND EQUIPMENT ABOVE CEILINGS FOR COORDINATION PURPOSES. IN THE EVENT OF CONFLICT OR IF DIMENSIONS ARE NOT SHOWN, OBTAIN FIELD DIRECTIVE FROM THE ARCHITECT AS TO THE LOCATIONS OF ALL VISIBLE EQUIPMENT.
- 6. THE SPRINKLER CONTRACTOR SHALL PROVIDE AS PART OF THIS CONTRACT ALL SPRINKLERS BELOW FIXED OBSTRUCTIONS 48" AND LARGER AS REQUIRED BY NFPA 13, 8.6.5.3.3. IT IS THE RESPONSIBILITY OF THE SPRINKLER CONTRACTOR TO PROVIDE THE REQUIRED SPRINKLERS AND ALL ASSOCIATED PIPING, FITTINGS, HANGERS, ETC. FOR A COMPLETE INSTALLATION.
- 7. ATTENTION IS CALLED TO THE REQUIREMENT FOR THE PREPARATION OF COORDINATION DRAWINGS. IN ADDITION TO THE PREPARATION OF SHOP DRAWINGS ALSO PREPARE COORDINATION DRAWINGS AS OUTLINED IN THE SPECIFICATION. THE APPROVAL OF THE SHOP DRAWINGS INCLUDING DIMENSIONS SHOWN THEREIN DOES NOT RELIEVE THE CONTRACTOR.
- 8. SPECIFIC ATTENTION IS DIRECTED TO THE REQUIREMENTS OF MBC 914.7, 3305.3, 3306.1, AND NFPA 241-2004 REGARDING THE MAINTENANCE OF FIRE PROTECTION SYSTEMS INCLUDING STANDPIPES AND BULK FIRE MAINS BOTH DURING CONSTRUCTION AND DEMOLITION. MAINTAIN THE SYSTEMS AS REQUIRED BY THESE STANDARDS AS A MINIMUM.
- 9. THE SPRINKLER CONTRACTOR SHALL PROVIDE AS PART OF HIS CONTRACT AN INSPECTOR'S TEST STATION ON EACH SPRINKLER ZONE. THE INSPECTOR'S TEST STATION WILL BE LOCATED AT THE MOST HYDRAULICALLY REMOTE PART OF EACH ZONE AND SHALL BE IDENTIFIED ON THE SPRINKLER SHOP DRAWINGS.
- 10. REFER TO NFPA 13 TABLE 8.3.2.5(a) FOR TEMPERATURE RATING OF SPRINKLERS BASED ON DISTANCE FROM HEAT SOURCES SUCH AS HEATING DUCTS, DIFFUSERS AND UNIT HEATERS.


10FT HORIZONTALLY FROM ANY OTHER SKYLIGHT OR UNPROTECTED CEILING POCKET.

- 11. INSTALL SPRINKLER IN ALL SPACES ABOVE CEILINGS GREATER THAN 24" HIGH FOR NON-COMBUSTIBLE
- CONSTRUCTION AND ABOVE CEILINGS GREATER THAN 6" HIGH FOR COMBUSTIBLE CONSTRUCTION. 12. SPRINKLERS SHALL BE PERMITTED TO BE OMITTED FROM SKYLIGHTS AND SIMILAR CEILING POCKETS NOT EXCEEDING 32 FT² IN AREA, REGARDLESS OF HAZARD CLASSIFICATION, THAT ARE SEPARATED BY AT LEAST

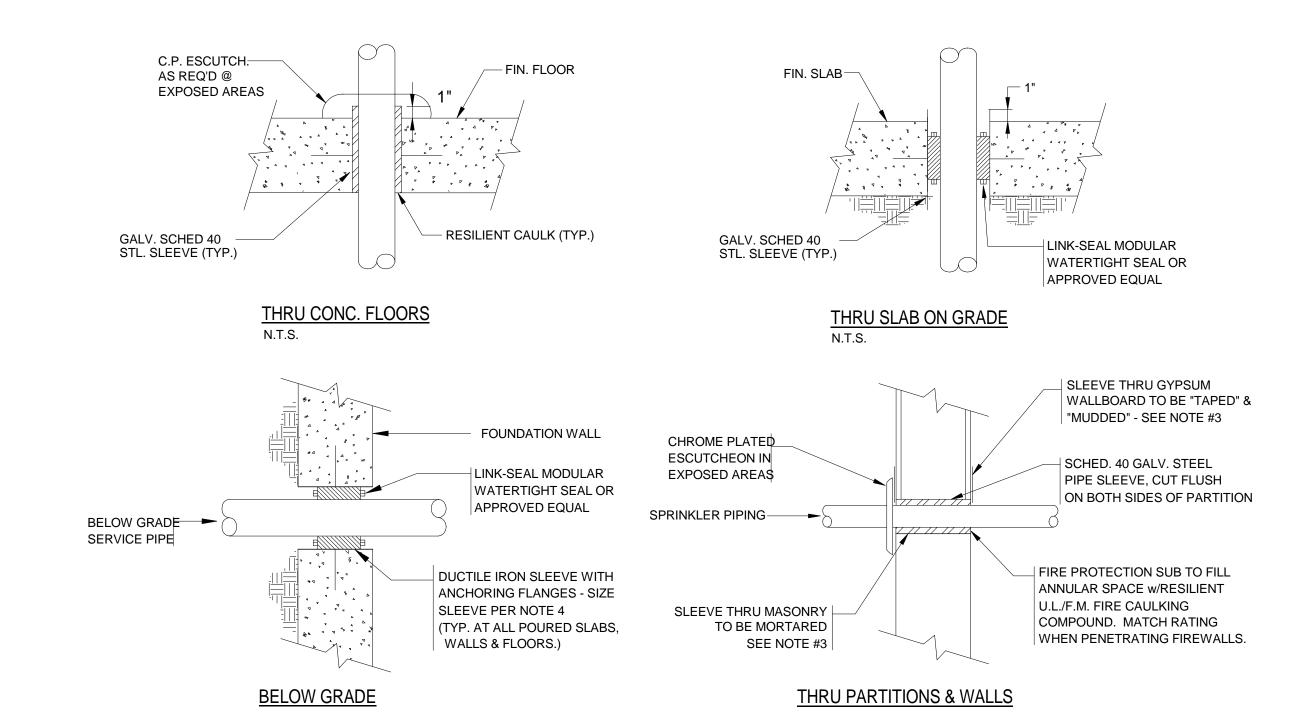


TYPICAL SLEEVE CONDITION DETAILS

- 1. ALL PIPING PENETRATING ALL PARTITIONS, WHETHER FIRE OR SMOKE RATED OR NOT, CONCEALED OR EXPOSED, SHALL BE SLEEVED AS DETAILED.
- 2. WHERE CONC. WALLS, SLABS, ETC., ARE CORE DRILLED, INSTALL SLEEVE FLUSH WITH BOTH SIDES, CAULKED & LEADED IN PLACE.
- 3. REFER TO DIVISION 4 & 9 FOR PROCEDURES & METHODS OF PATCHING AROUND SLEEVES AT GYPSUM, PLASTER & MASONRY. REFER TO SPECS FOR DELINEATION OF RESPONSIBILITY
- 4. SLEEVES SHALL BE SIZED TO PROVIDE MIN. 1" CLEARANCE BETWEEN PIPE O.D. & SLEEVE I.D. FOR PIPING UP TO 3" IN SIZE. PROVIDE 2" CLEARANCE BETWEEN PIPE O.D. & SLEEVE I.D. FOR PIPING 4" IN SIZE AND GREATER.

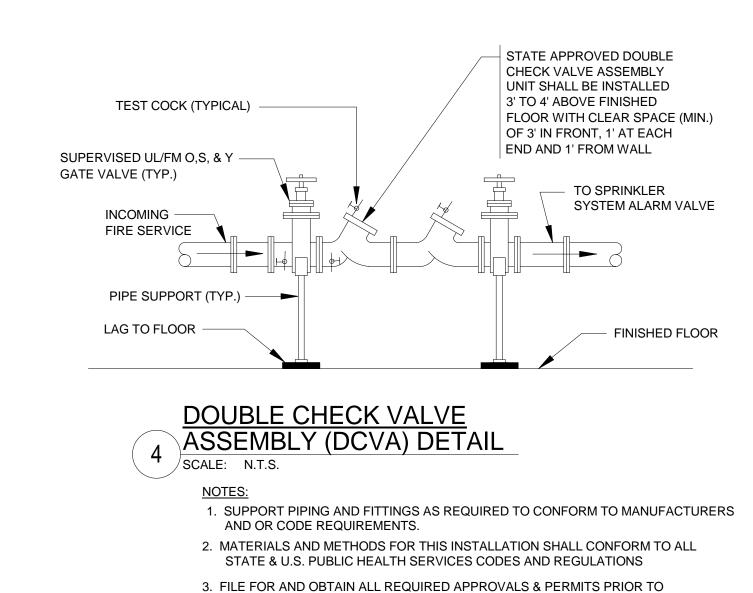

INSTALLATION

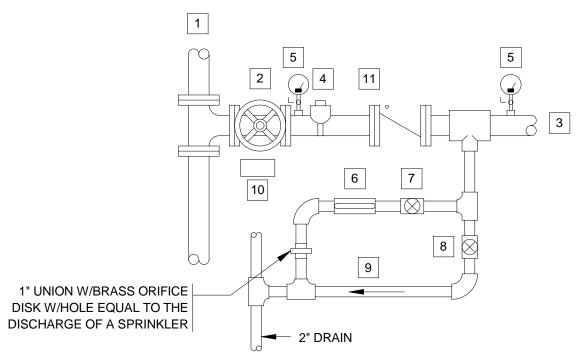


- 1 COMBINATION F/SP. STANDPIPE 6 1" SIGHT GLASS 2 UL/FM INDICATING TYPE CONTROL VALVE 7 1" INSPECTORS TEST VALVE PRESSURE RESTRICTING TYPE TO BE USED UP TO NINTH FLOOR 8 1" AUXILIARY DRAIN VALVE 3 TO CROSS CONNECTED SPRINKLER SYSTEM 9 1" DRAIN LINE 4 WATERFLOW SWITCH
- 10 IDENTIFICATION SIGN 5 PRESSURE GAUGE WITH COCK 11 UL/FM CHECK VALVE

SPRINKLER CONTROL VALVE


ASSEMBLY (SCVA) DETAIL

SCALE: N.T.S.

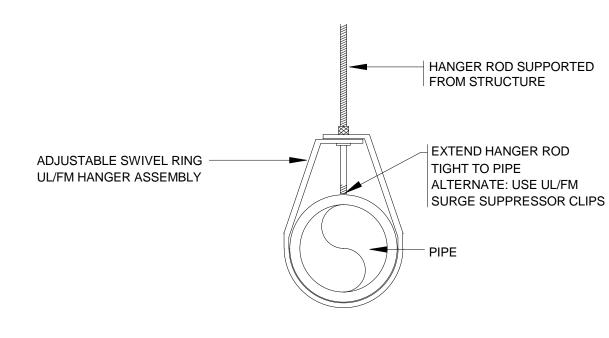


TYPICAL END-OF-LINE BRANCH PIPE HANGER DETAIL

> NOTE: TO BE USED AT ALL END-OF-LINE BRANCH HANGERS THROUGHOUT PROJECT

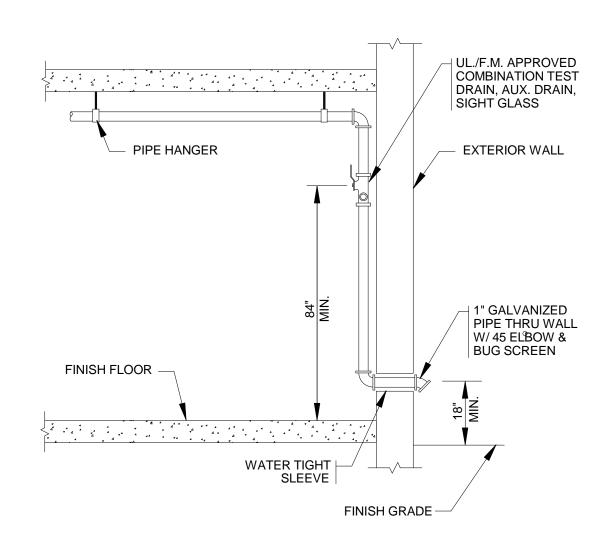

INSPECTOR'S TEST STATION

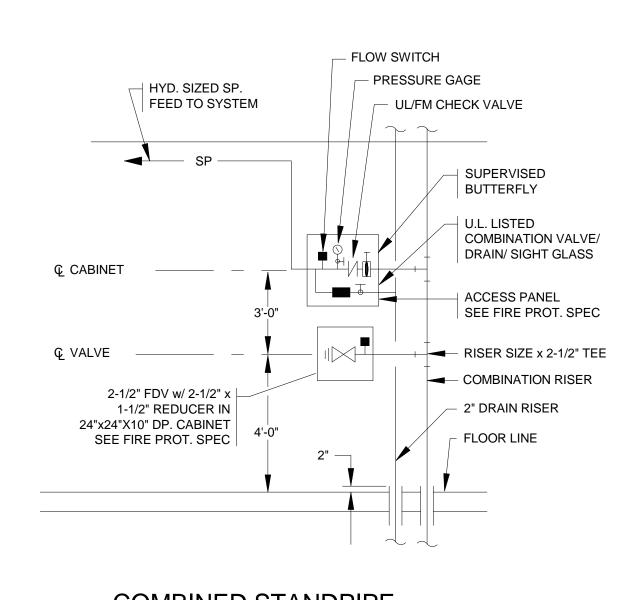

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LEGEND, DETAILS & NOTES -Design Development Submission FIRE PROTECTION Drawn: Checked:


August 15, 2012

1102.00 Drawing No.:

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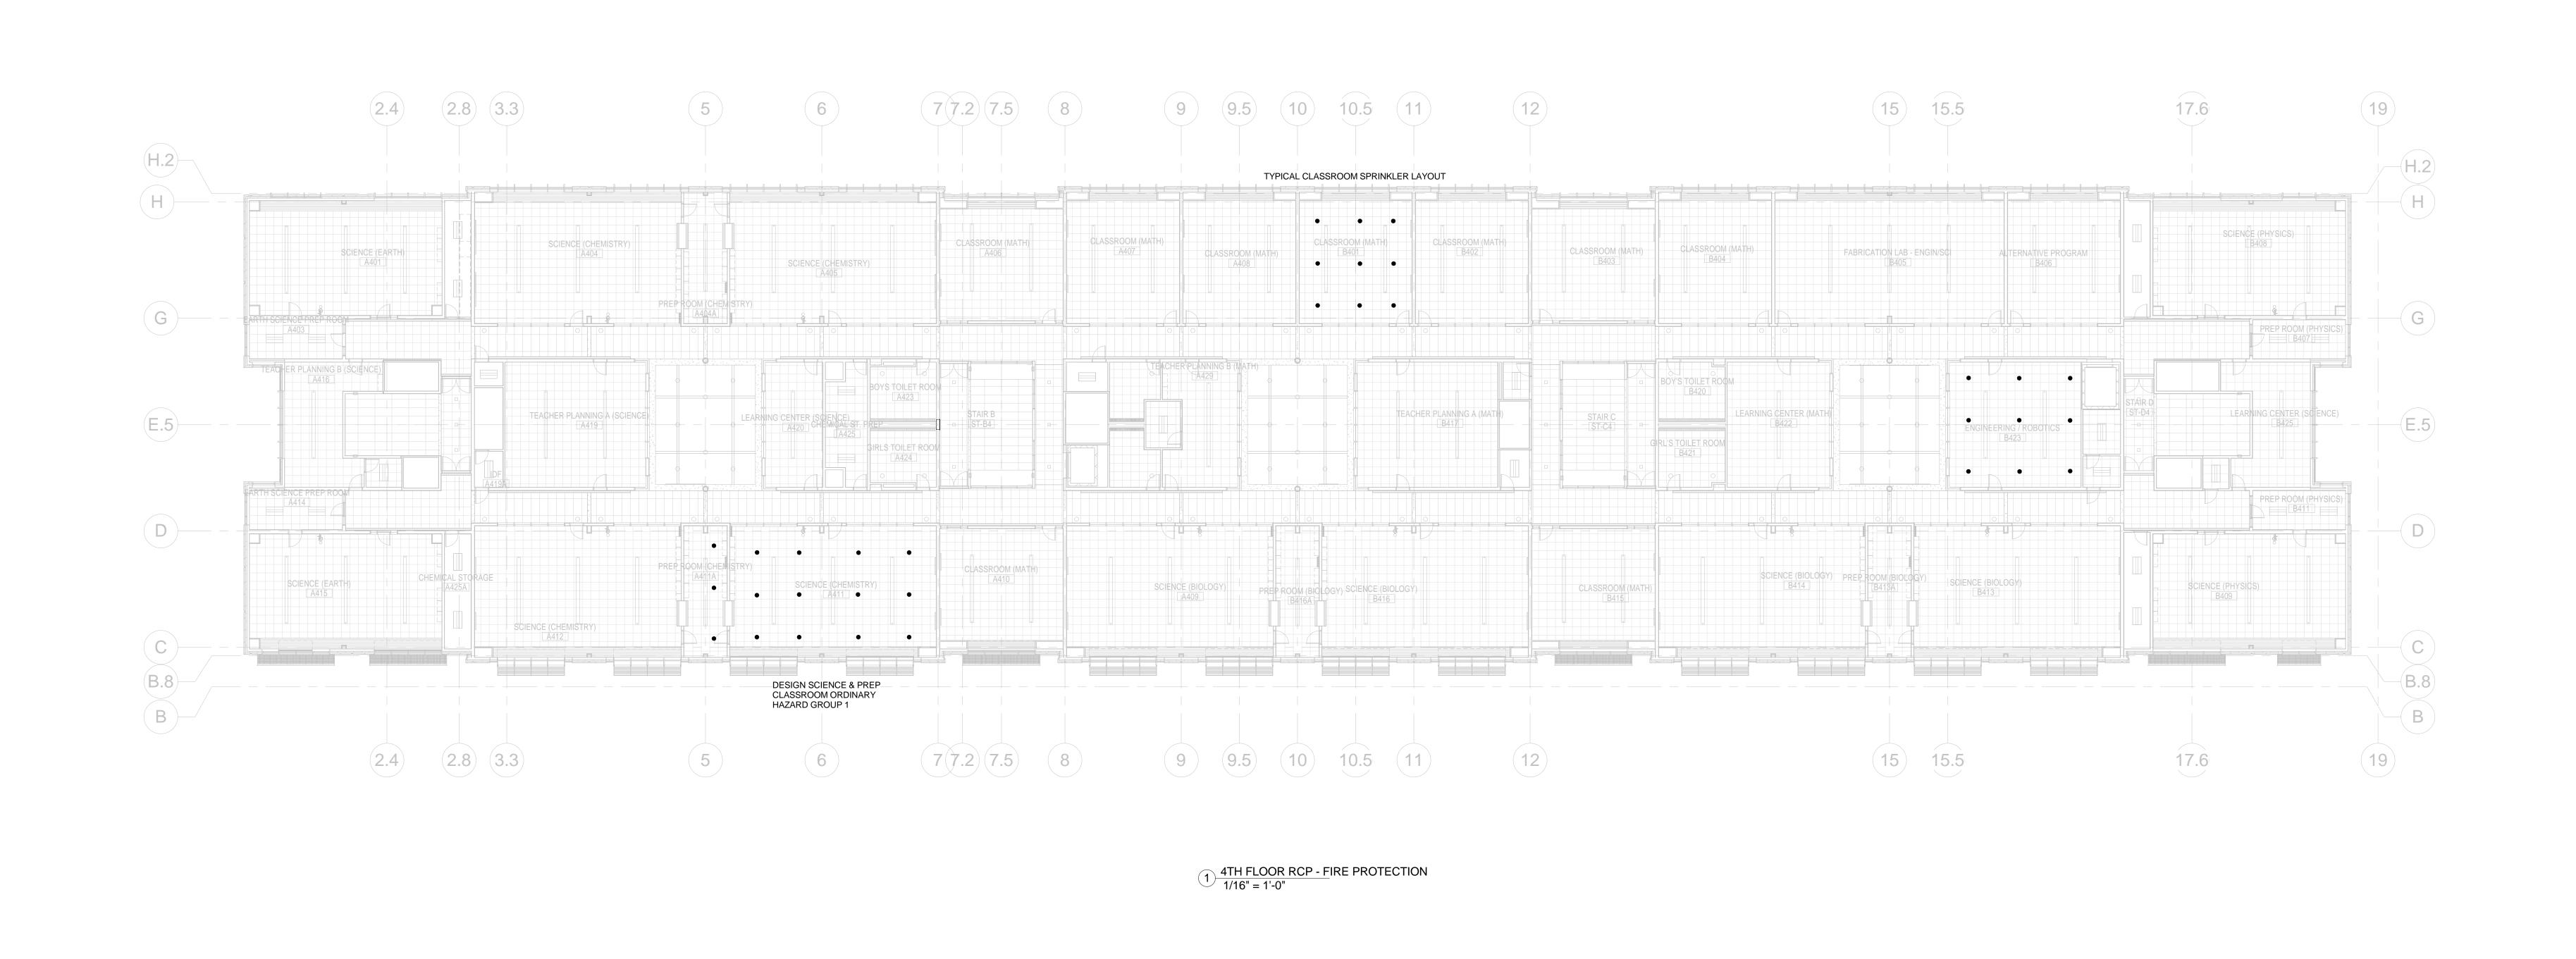
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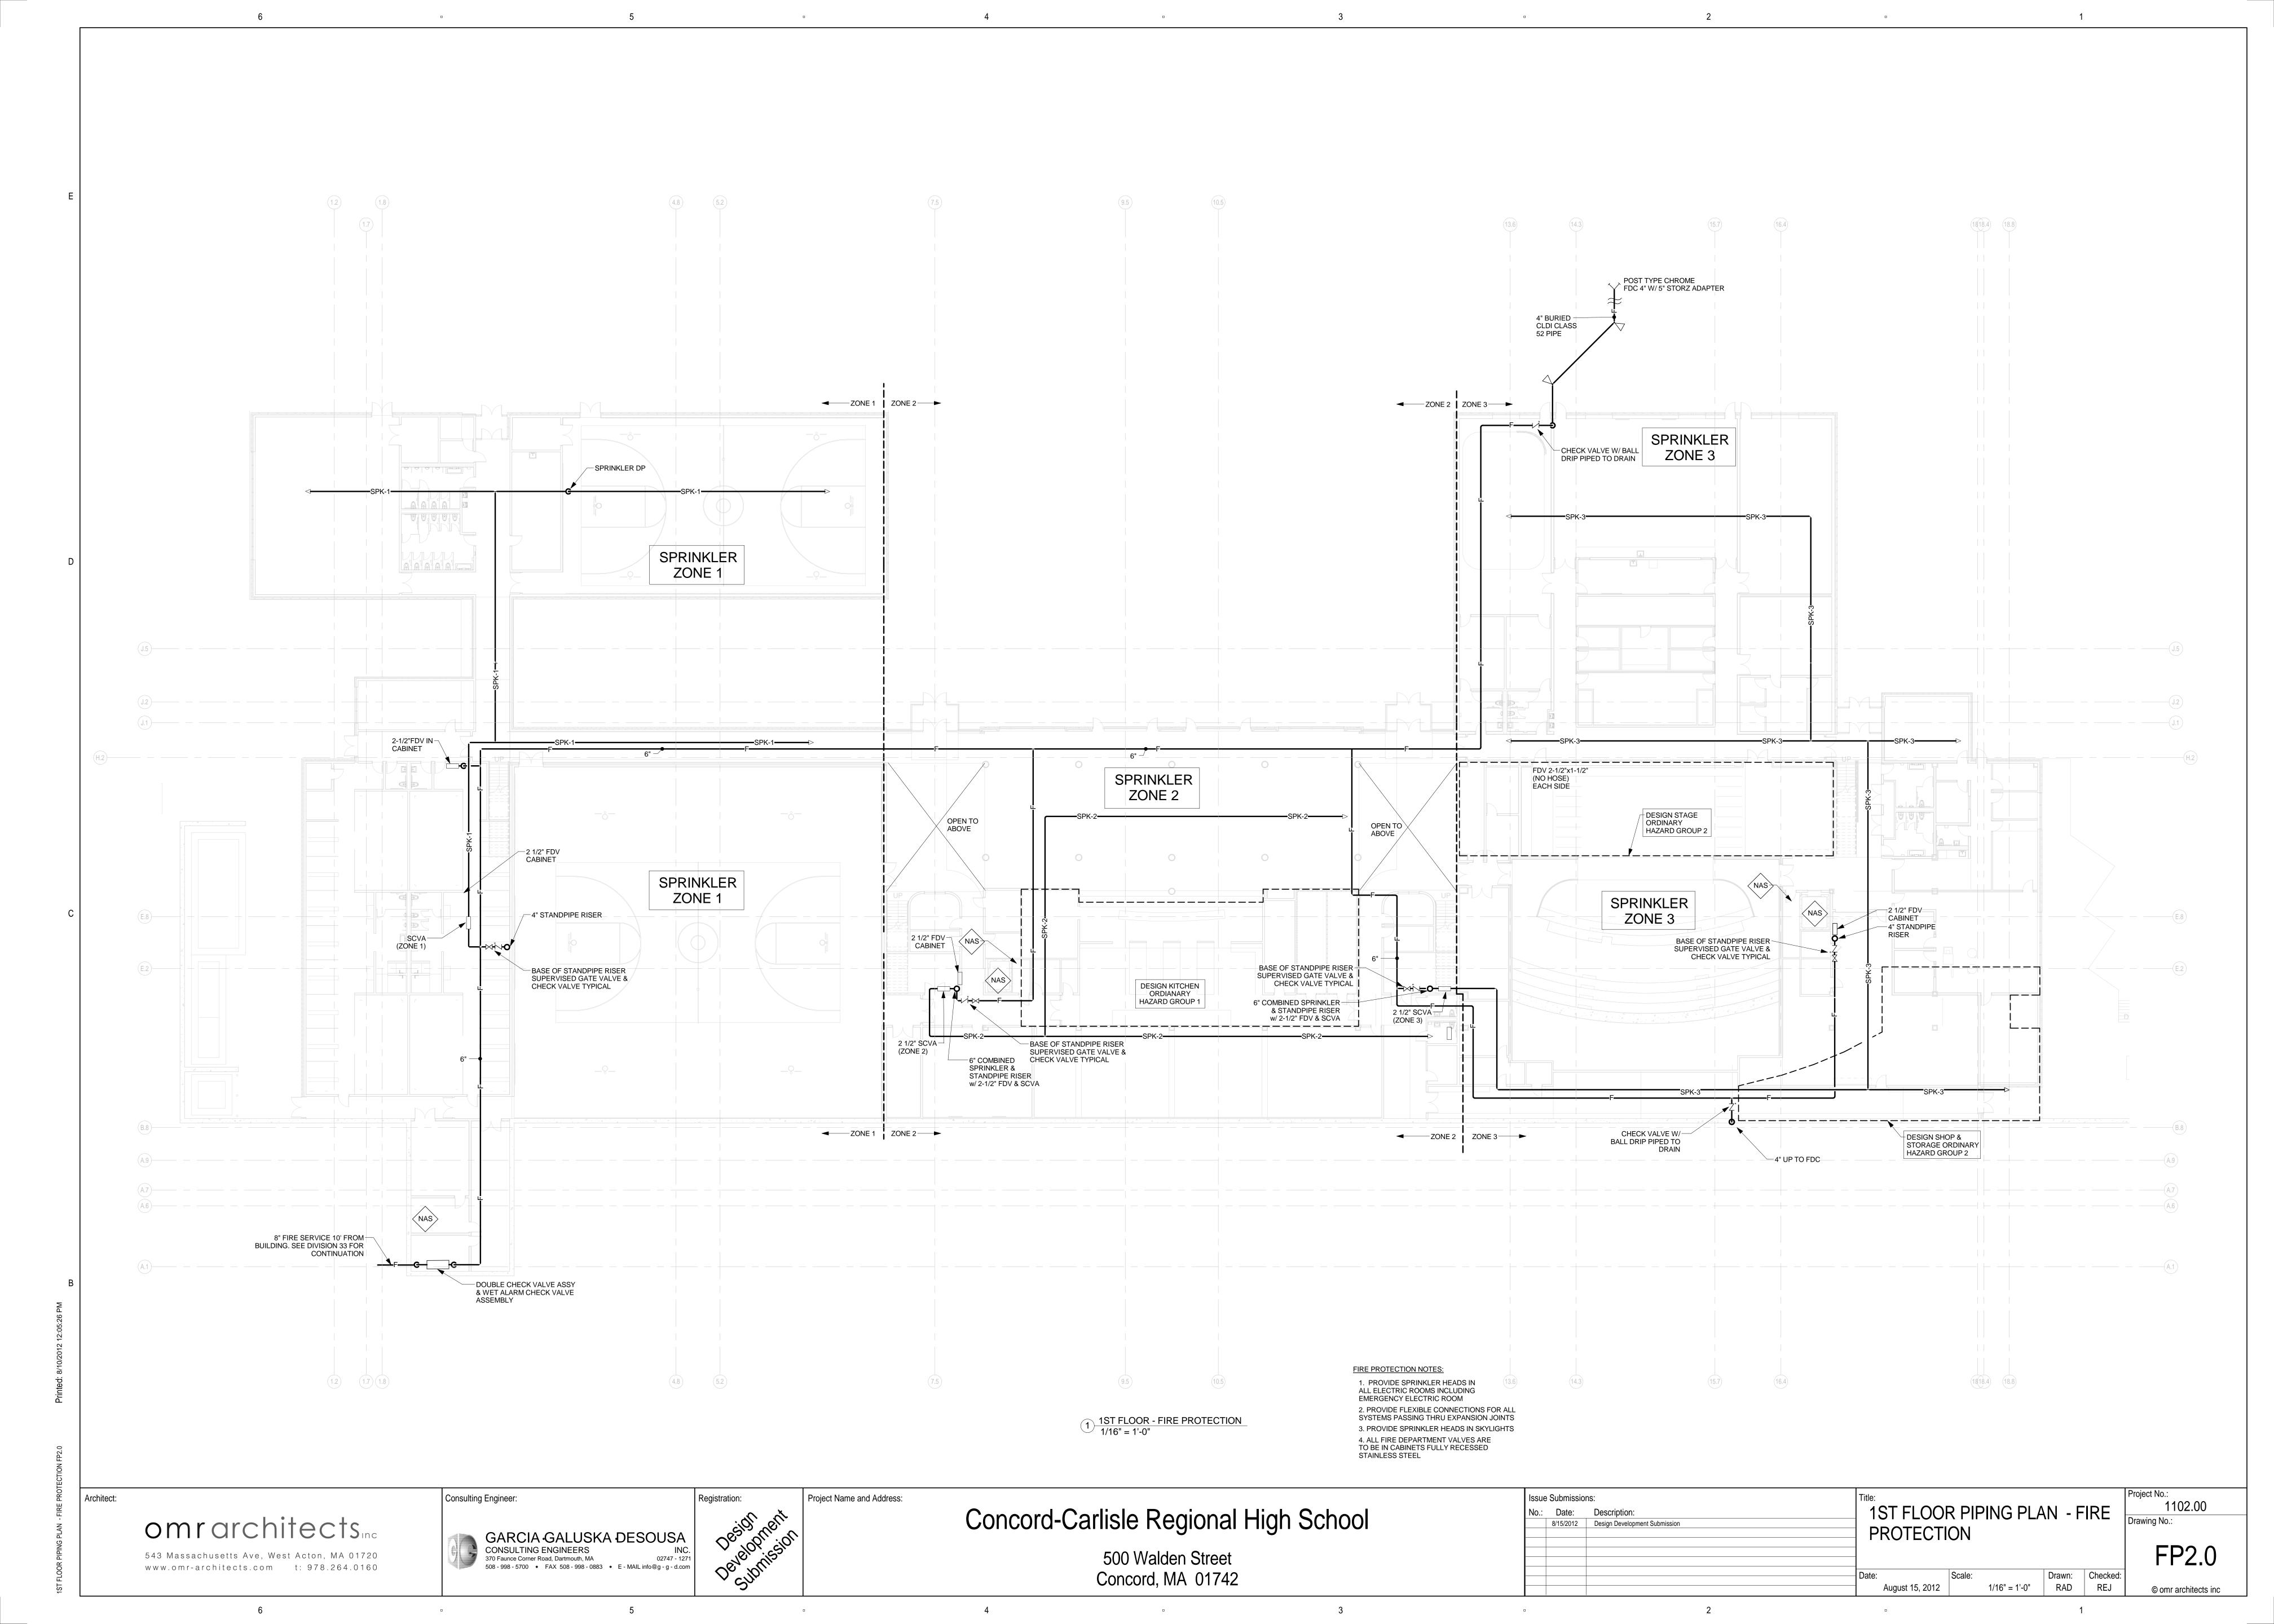
4TH FLOOR SPRINKLER Design Development Submission LAYOUT - FIRE PROTECTION


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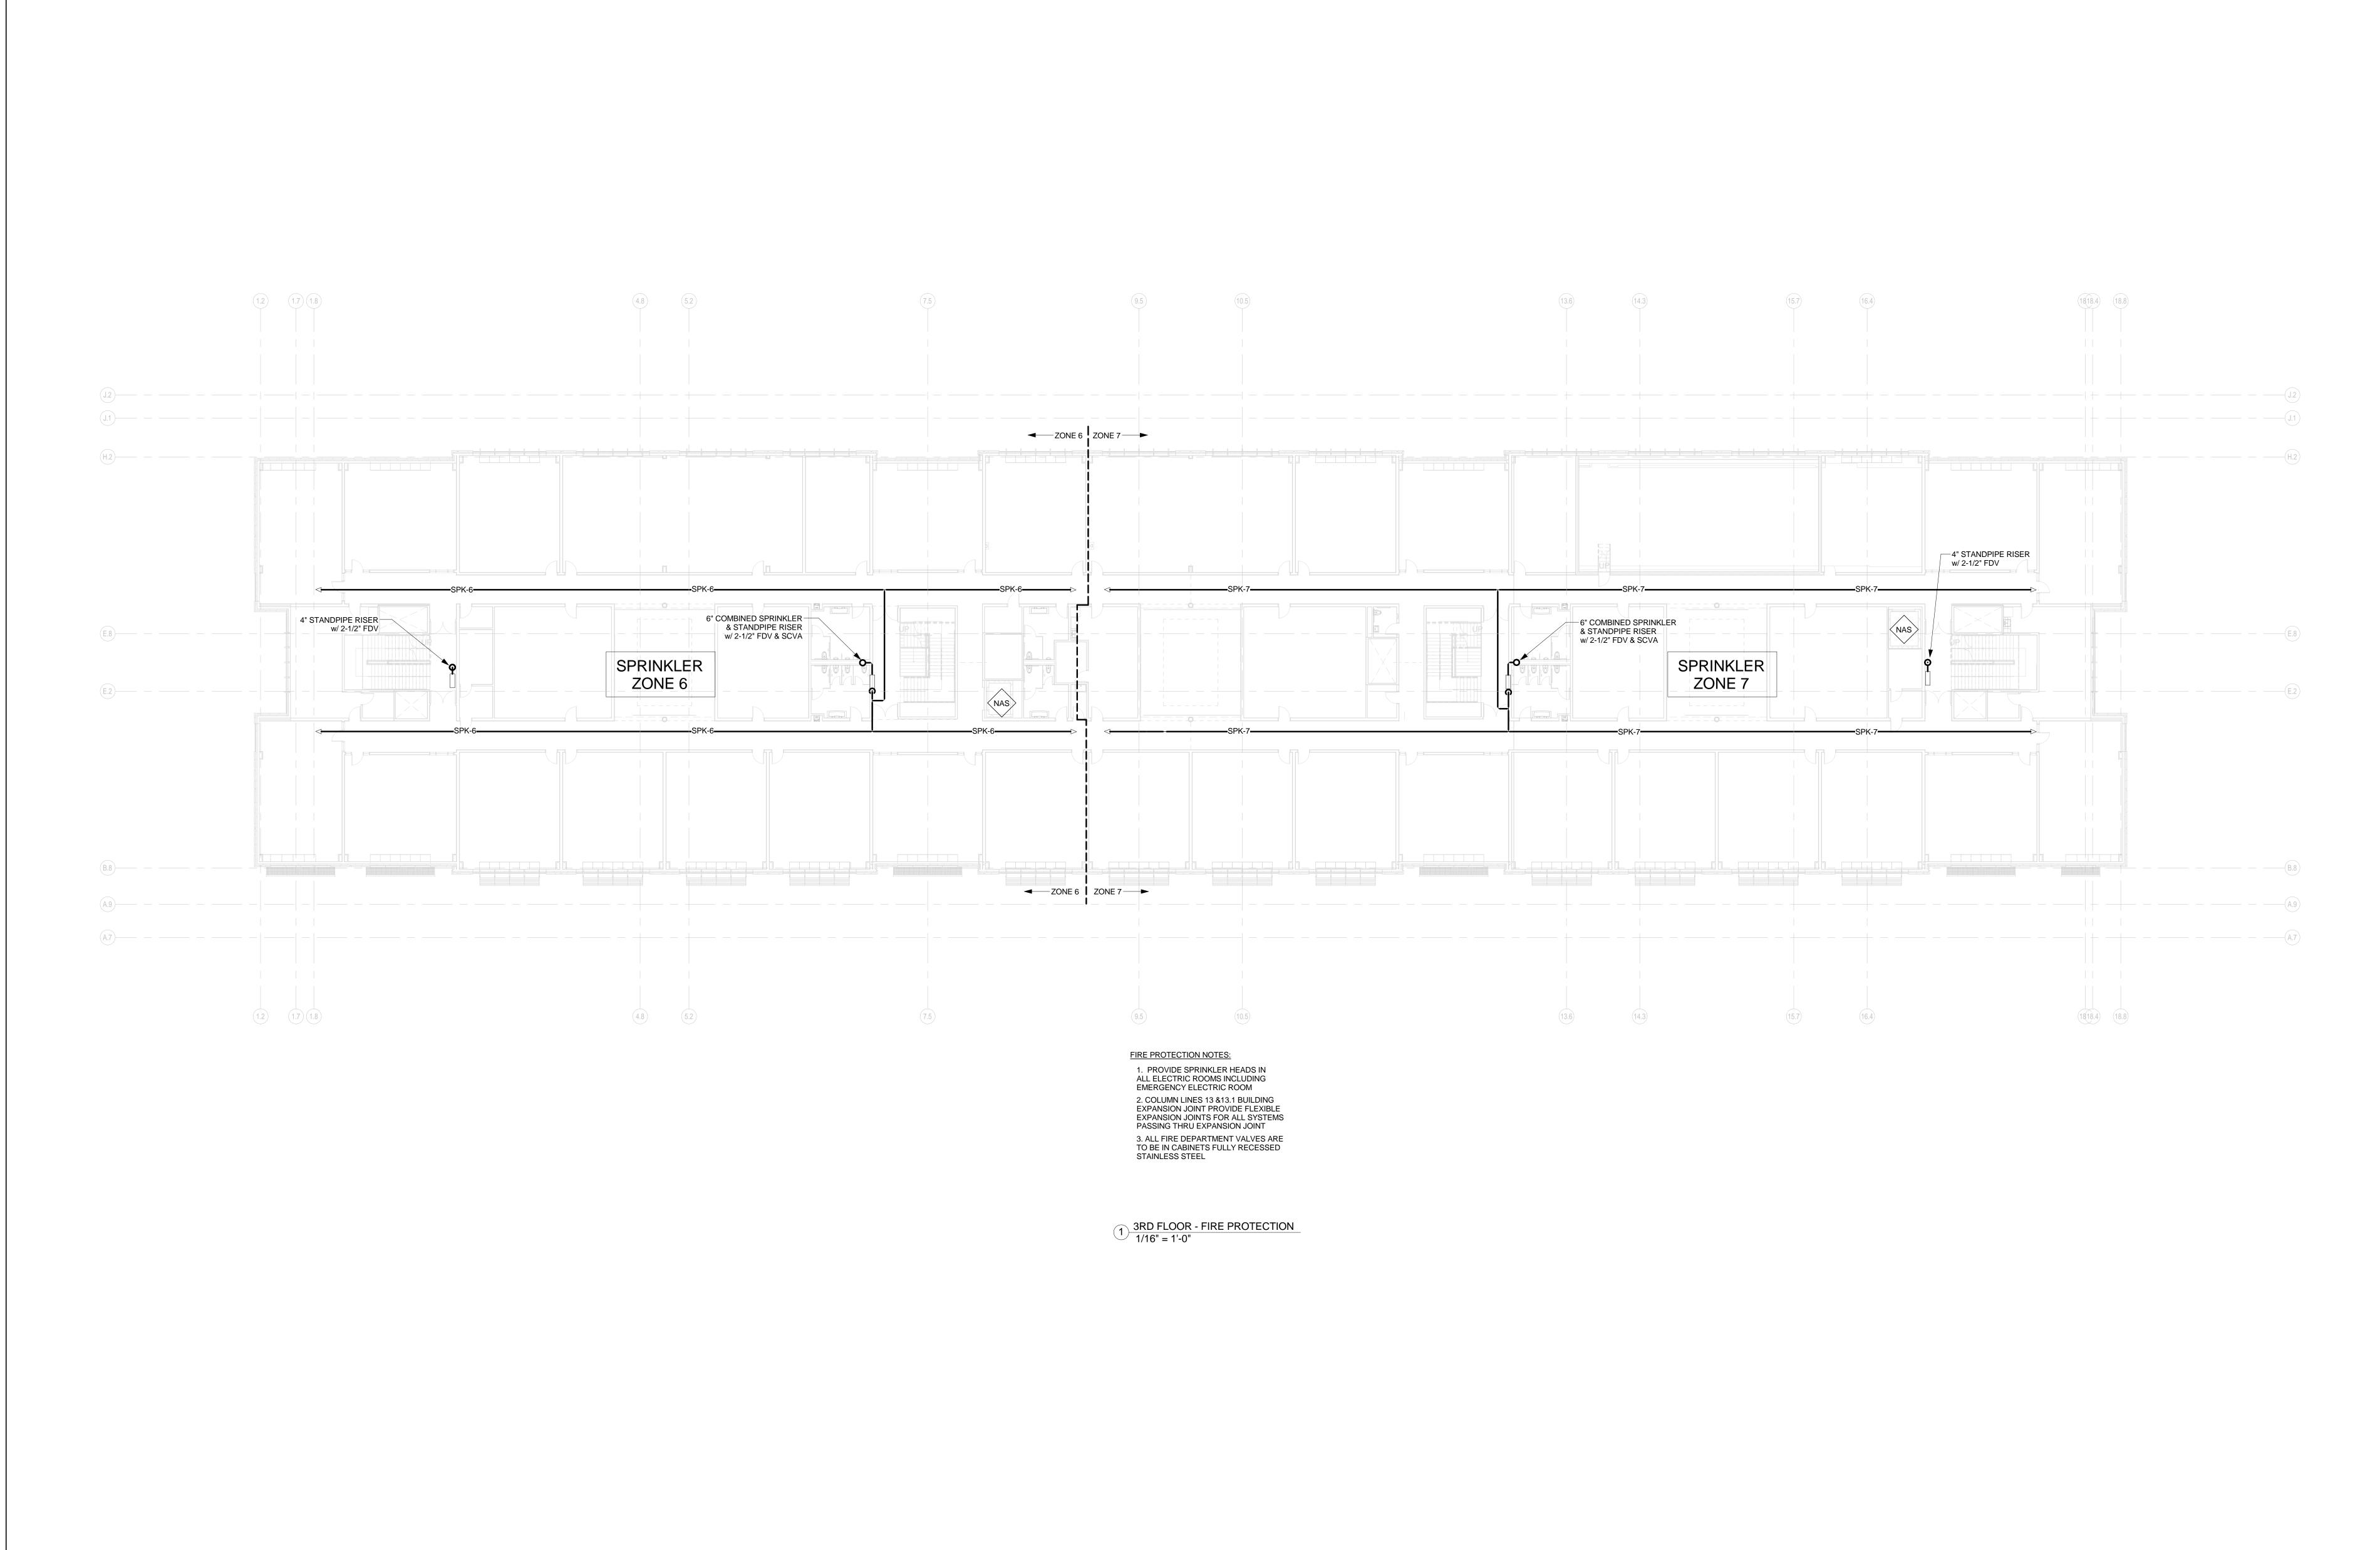
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Drawn: Checked:

1/16" = 1'-0" Author Checker

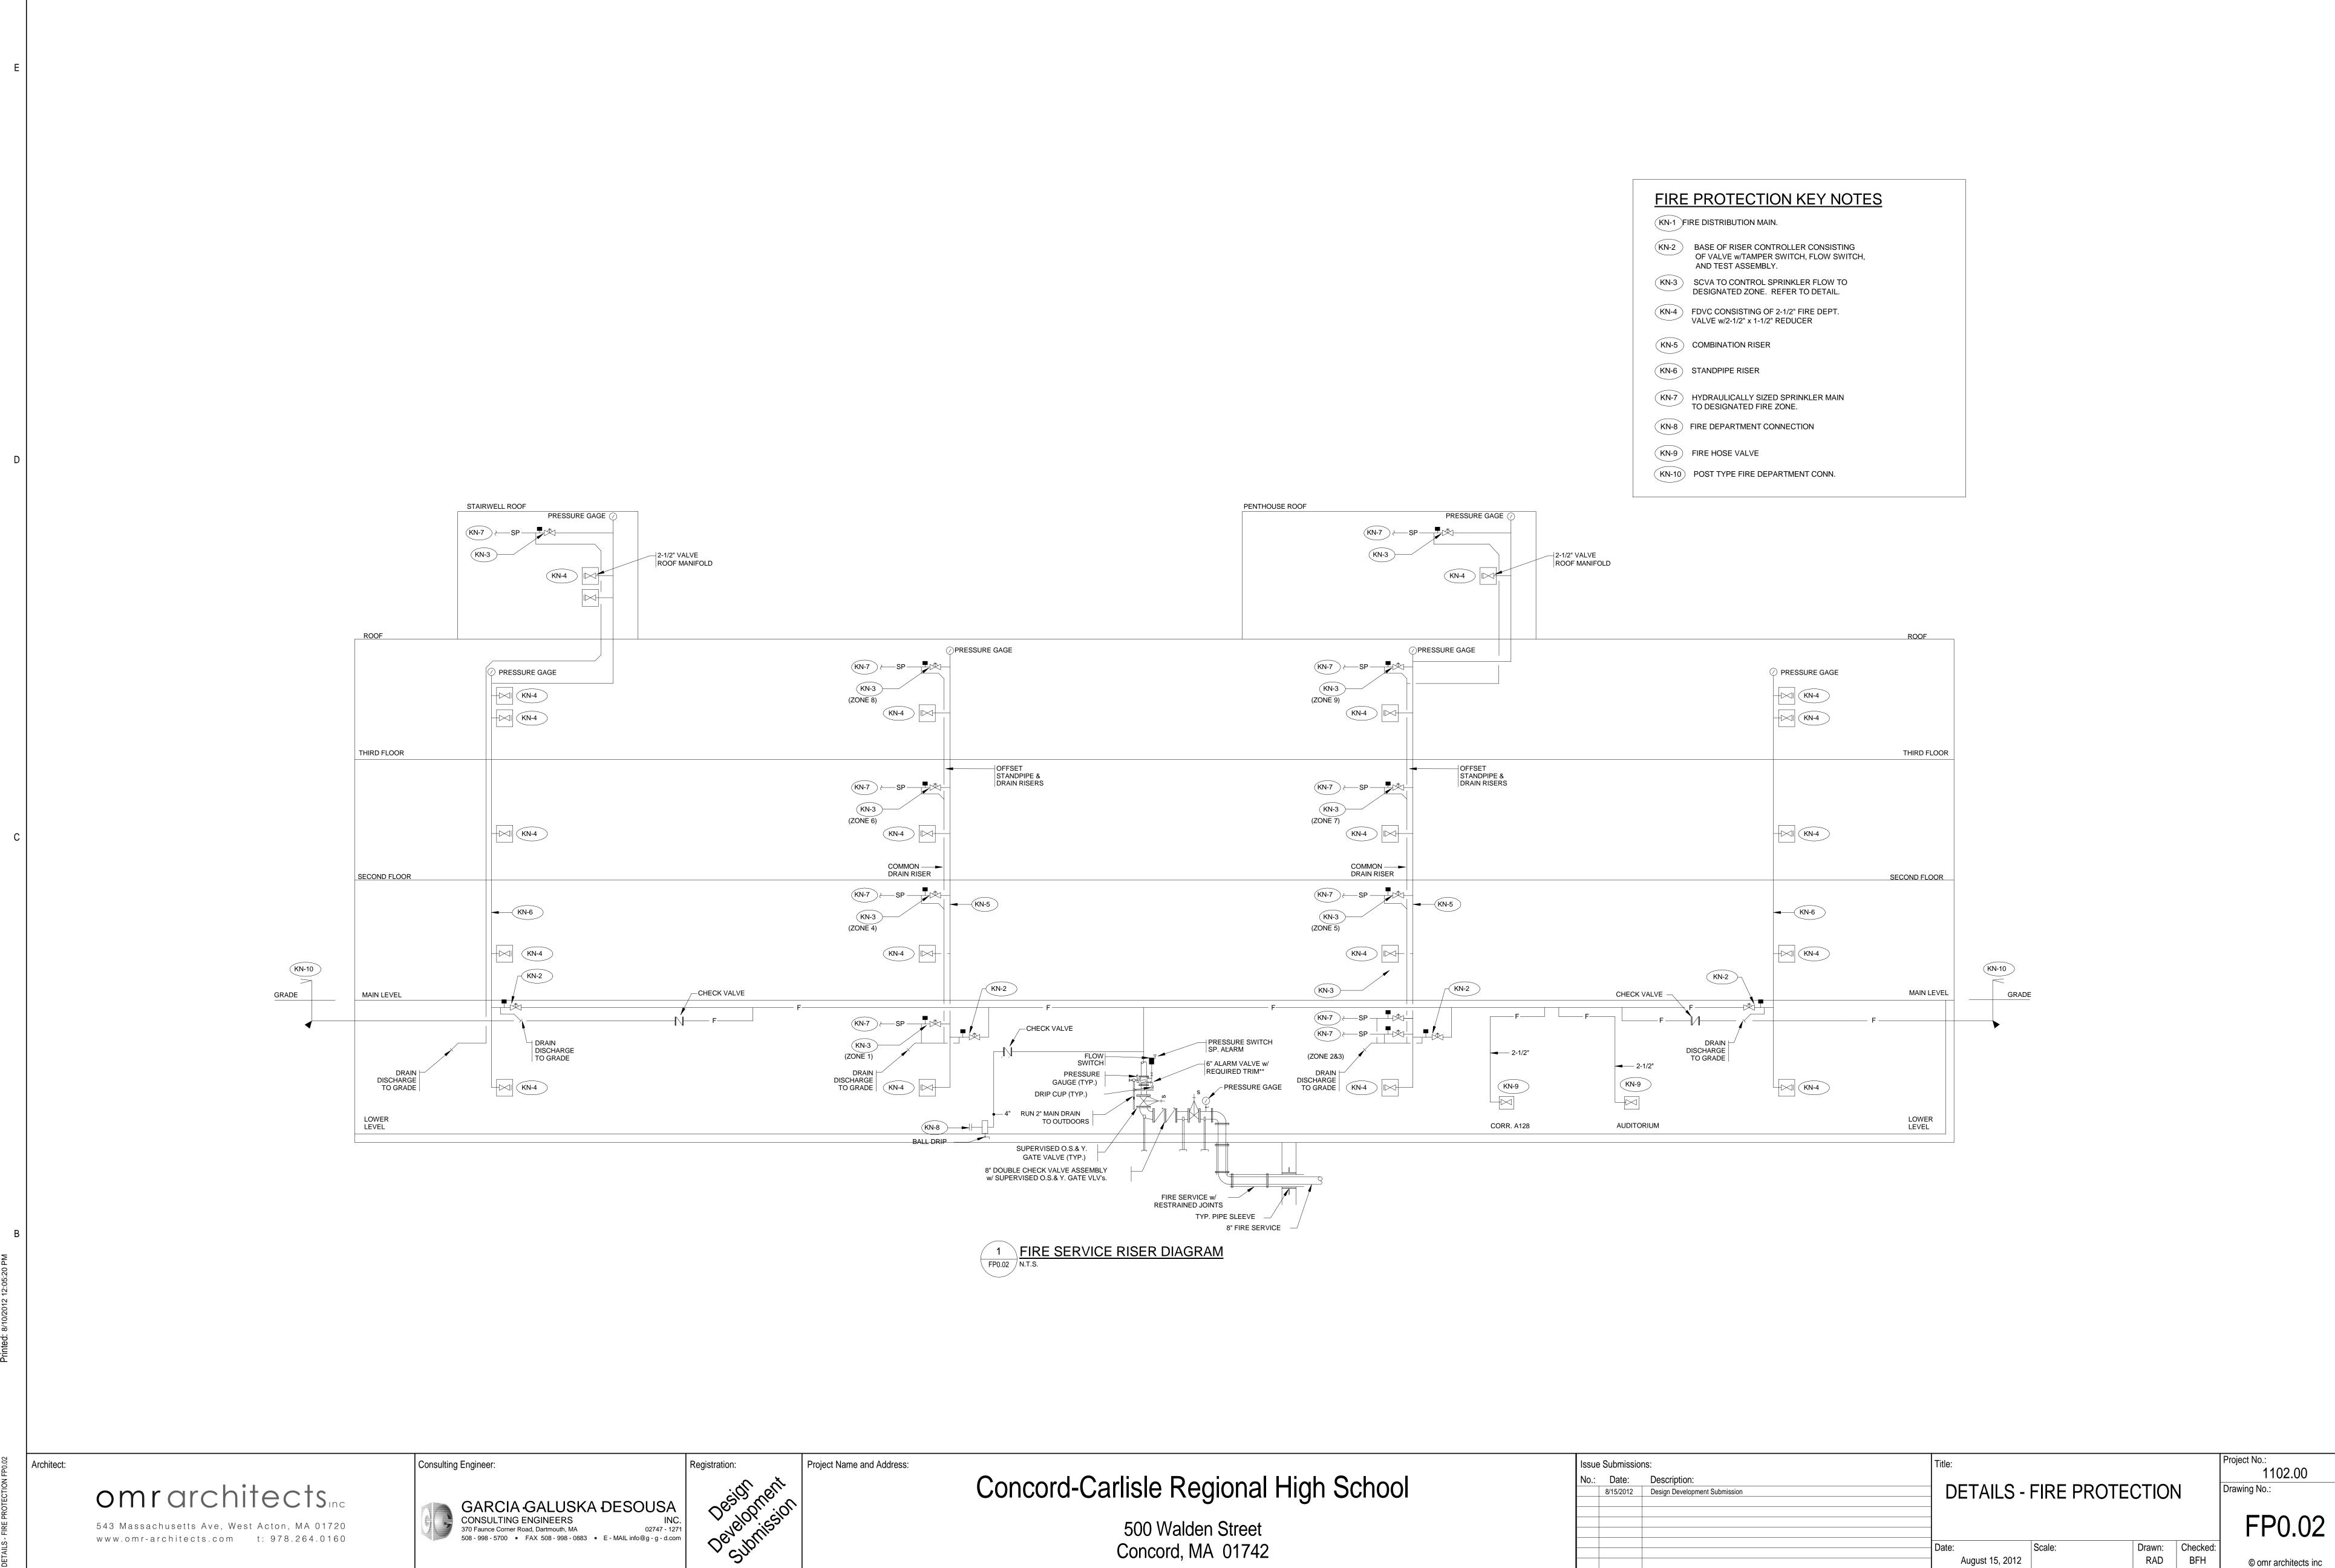



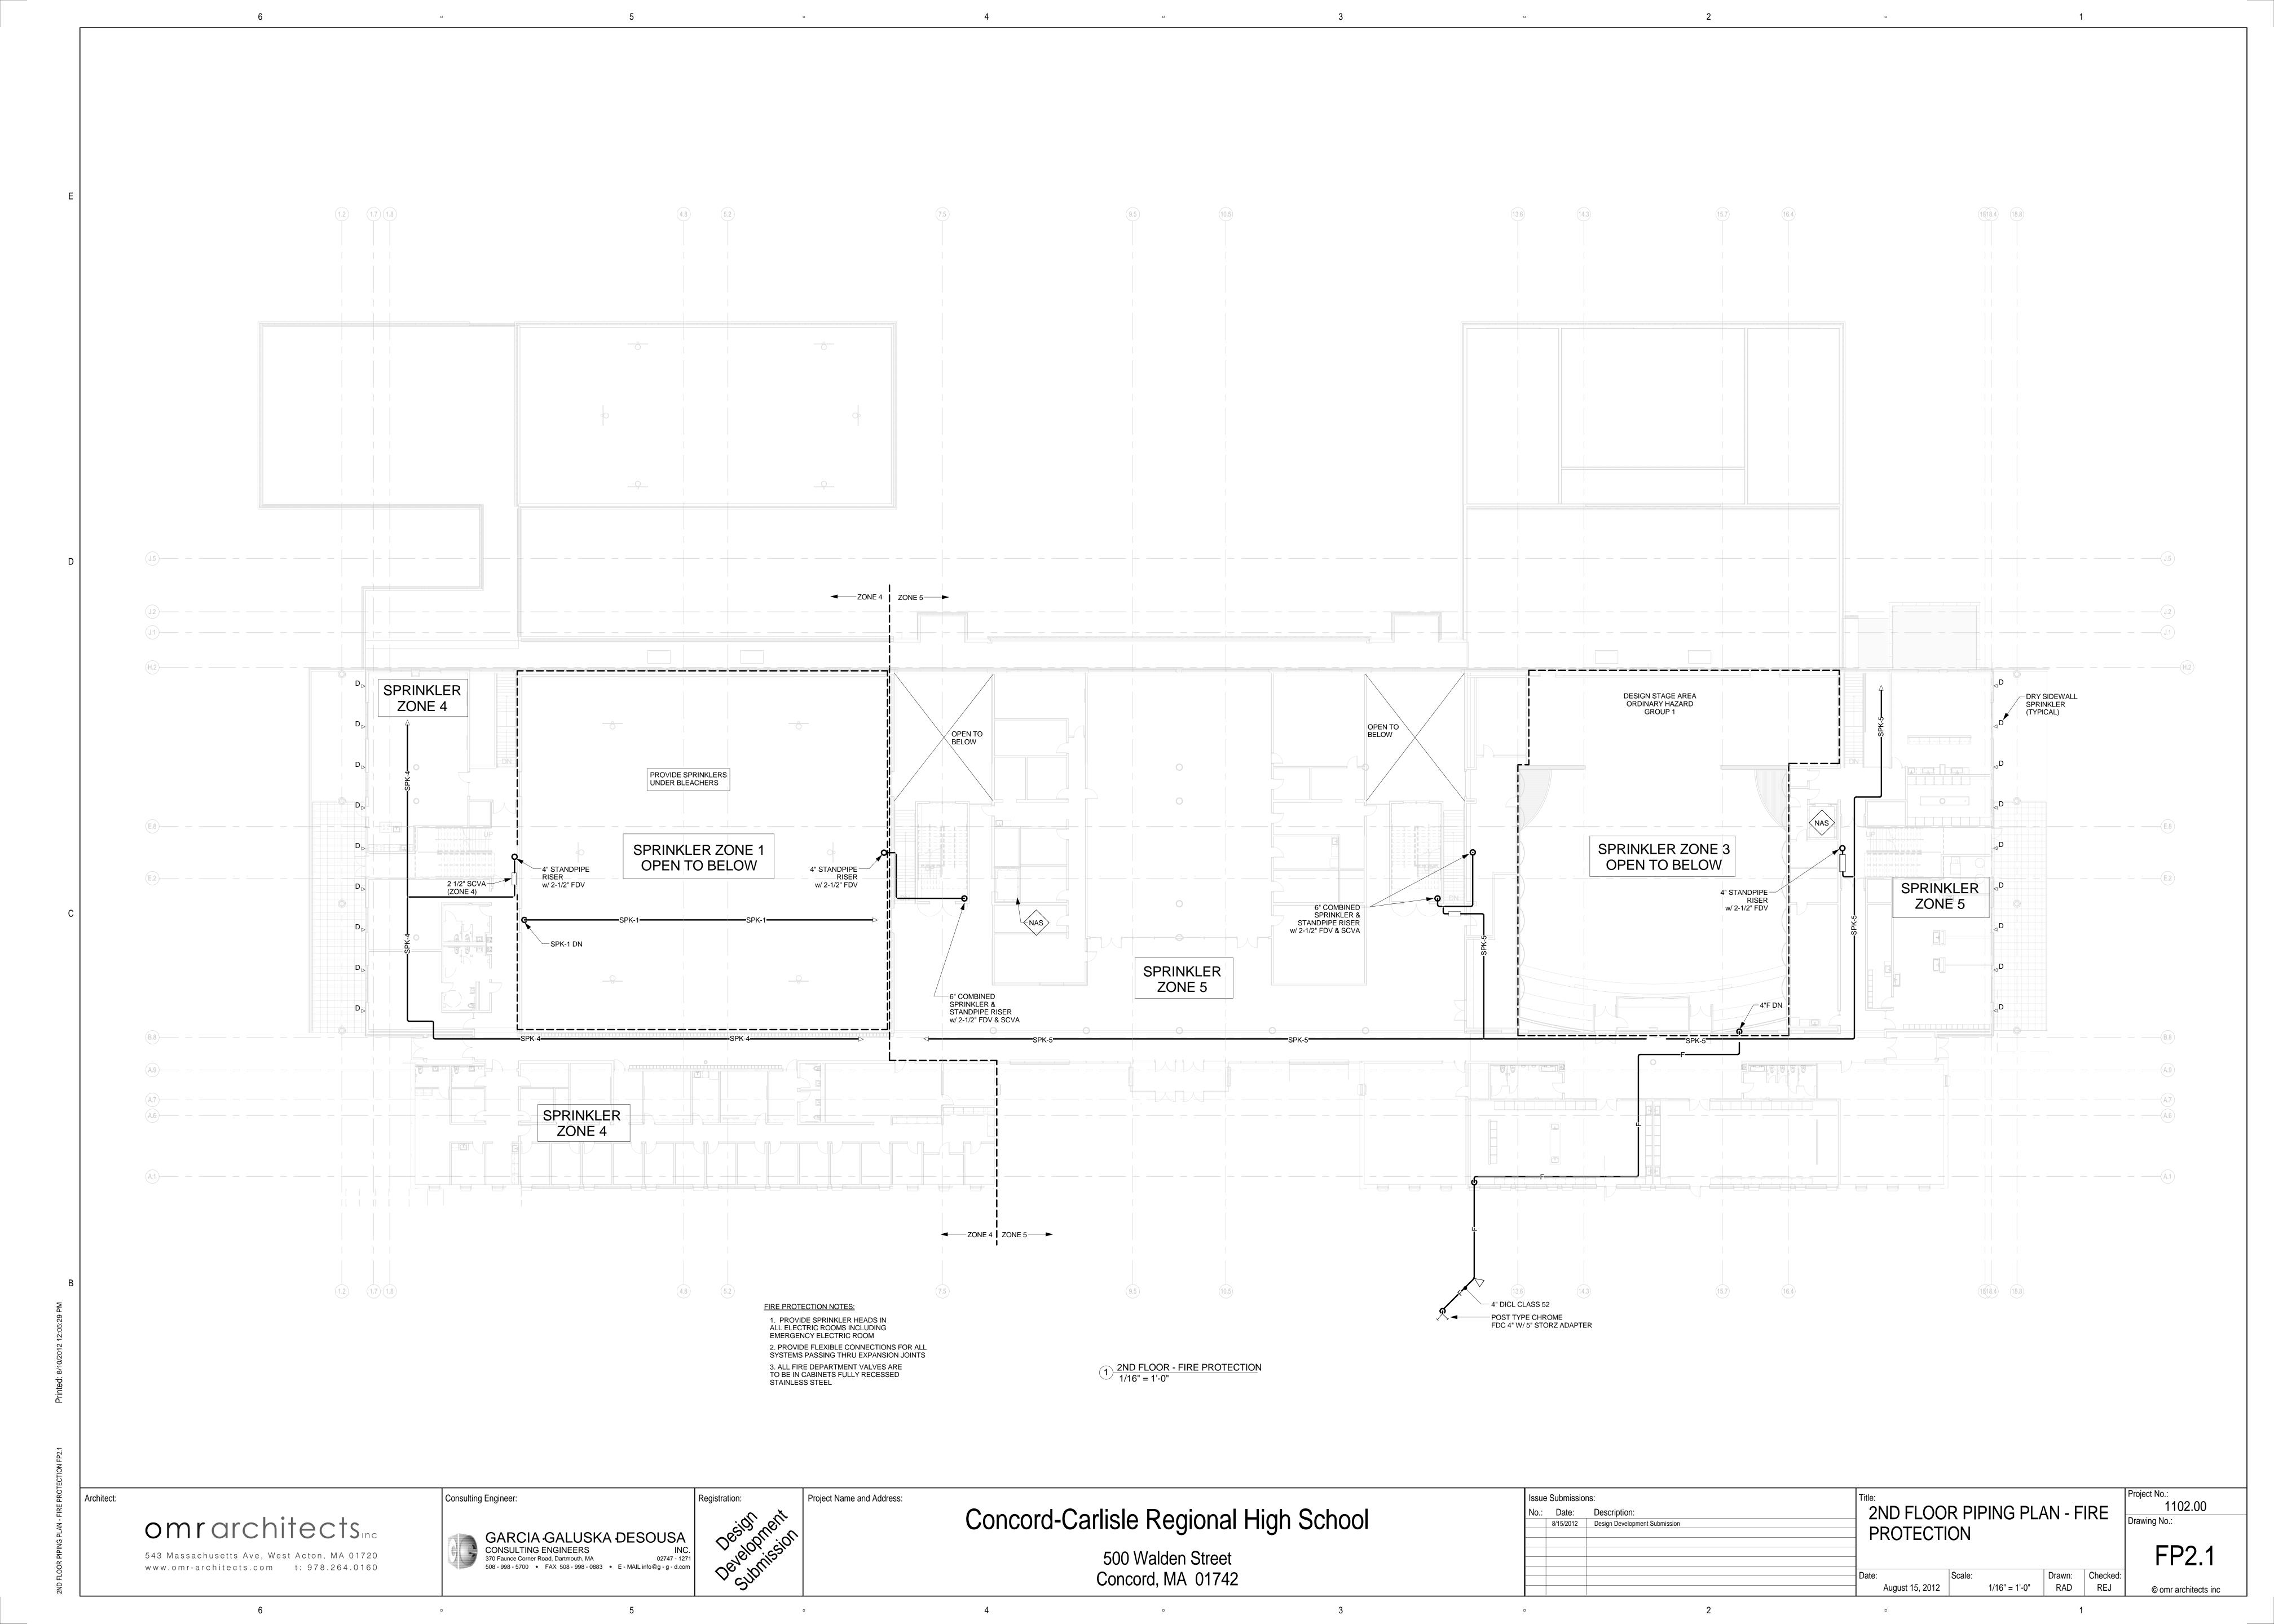

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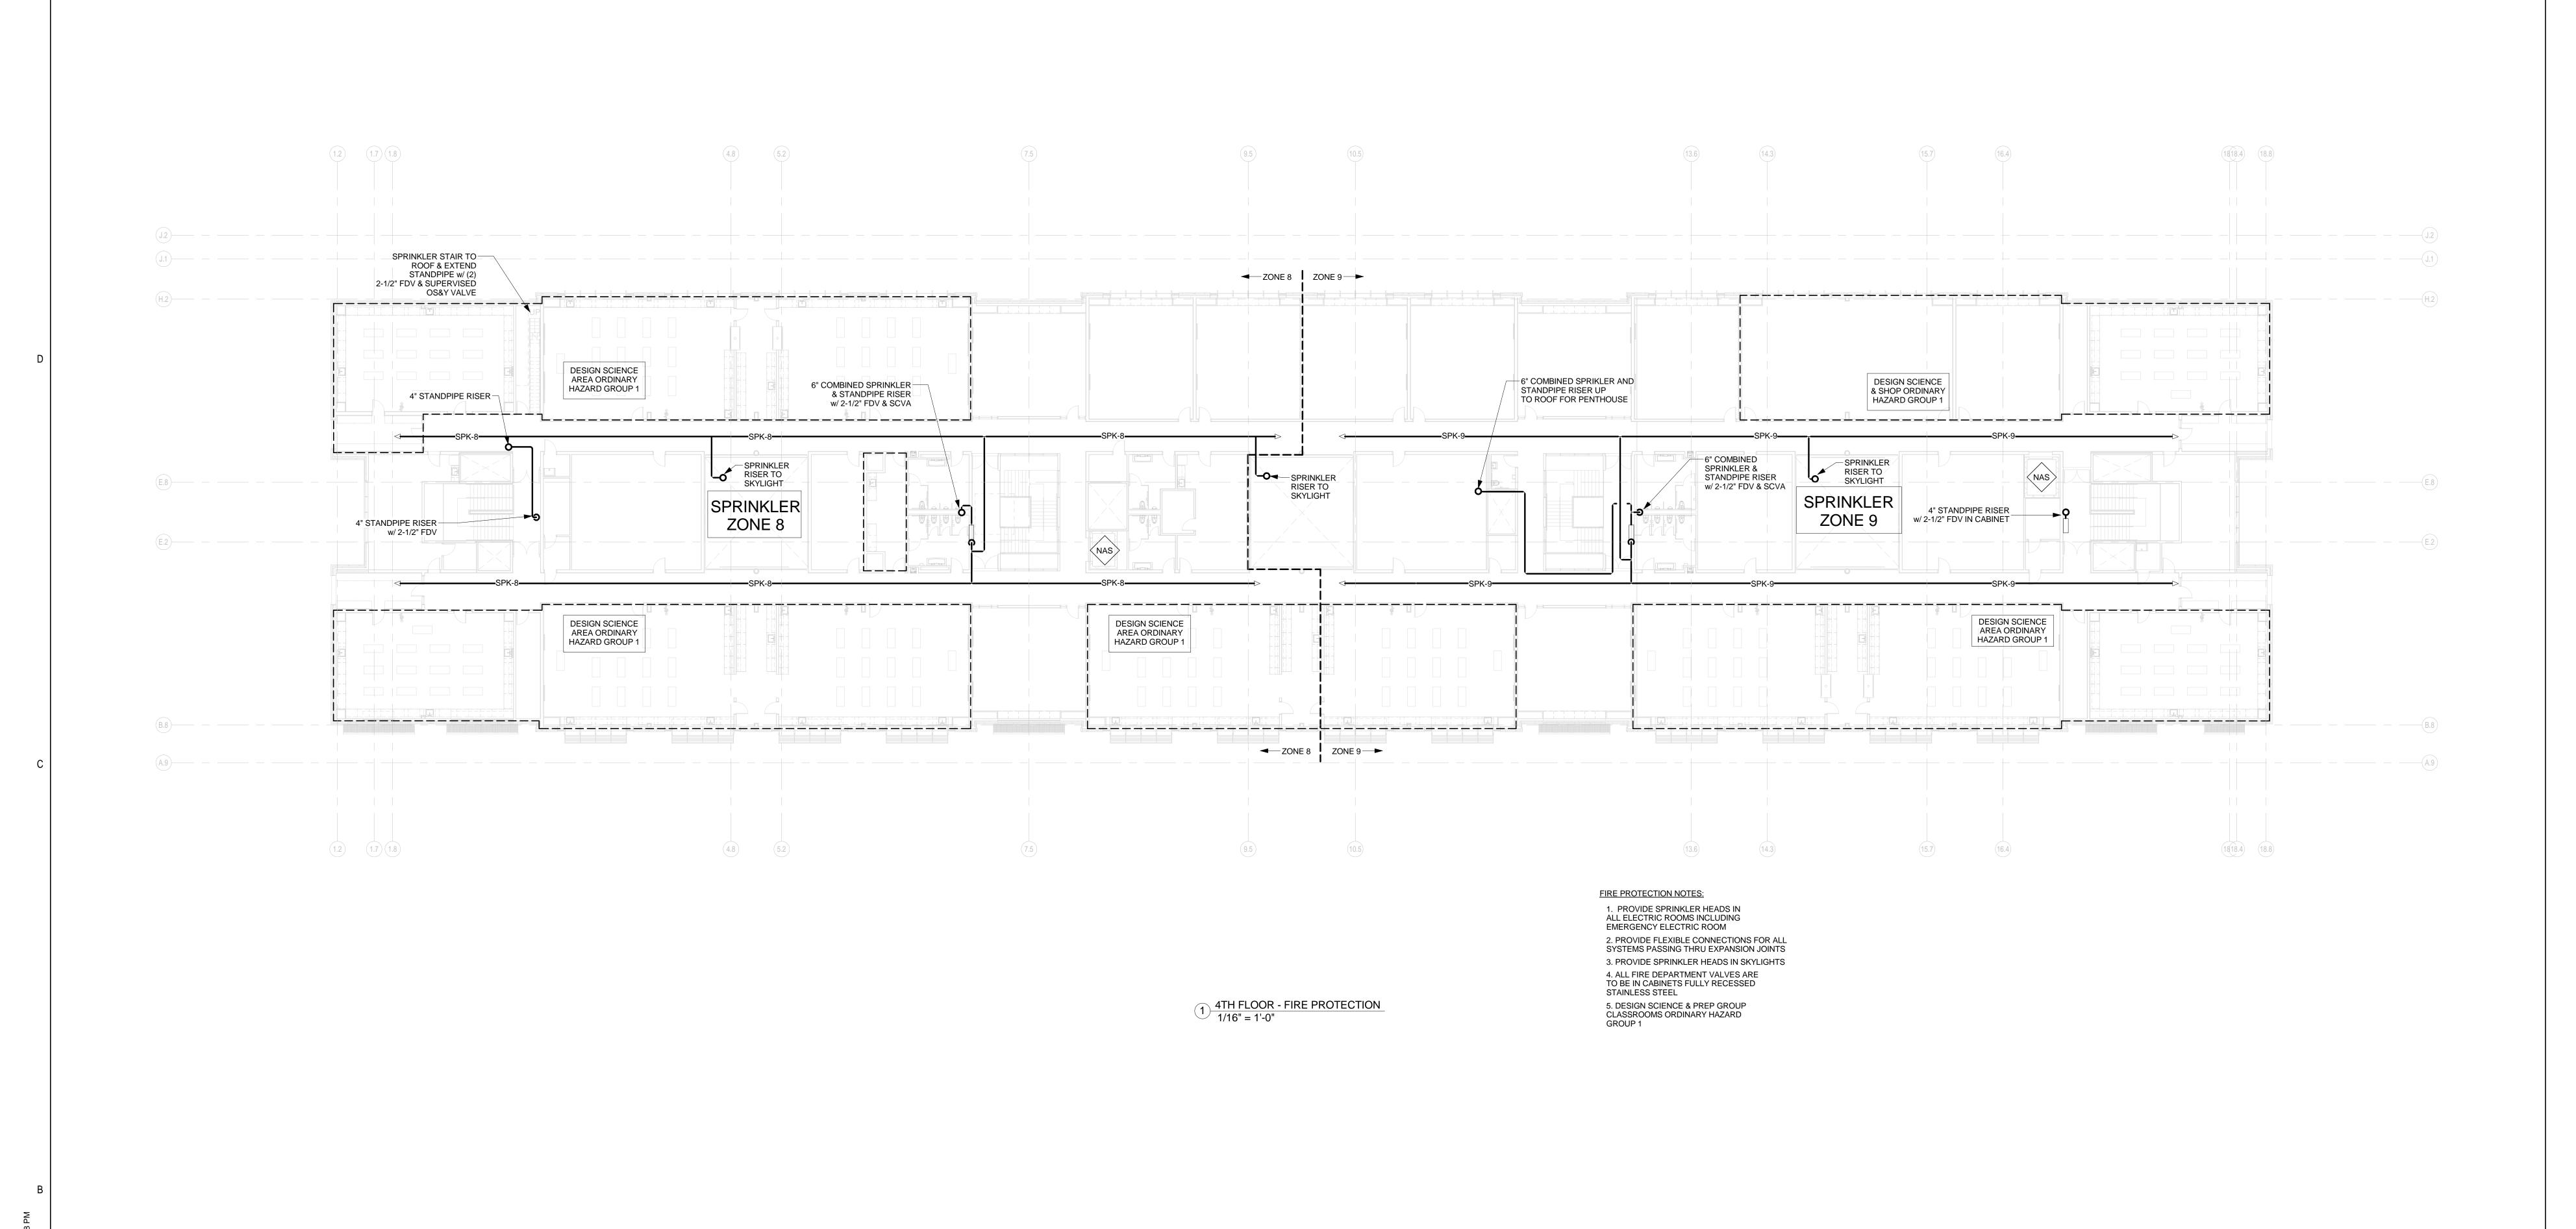
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3RD FLOOR PIPING PLAN - FIRE PROTECTION

FP2.2

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500 Walden Street Concord, MA 01742 Description:

Design Development Submission

Title:

4TH FLOOR PIPING PLAN - FIRE
PROTECTION

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